ANCHOR PHASE 3/ ZONING DRAWINGS

SHEET | DESCRIPTION

001 | TITLE SHEET

a001 | **Overall Site Plan**

A005 ELEVATIONS I

A002 | ENLARGED SITE PLAN |

A003 ANTENNA LAYOUT PLANS & ANTENNA SCHEDULE

SITE NUMBER: HI02051E SITE NAME: HECO MALAE

SITE TYPE: WOOD POLE

CITY: **KAILUA** HONOLULU COUNTY: JURISDICTION: CITY & COUNTY OF HONOLULU

T - Mobile -





THIS WORK WAS PREPARED BY ME OR UNDER MY UNDER MY OBSERVATION.

EXPIRATION DATE OF THE LICENSE

APV BY:

PAD ISSUE STATUS

REV	DATE	DESCRIPTION	BY
0	05/24/2022	100% CONSTRUCTION	BG
1	03/06/2024	PER JX AND HECO COMMENTS	BG
2	03/10/2025	PER HECO COMMENTS	DRG

HI02051E HECO MALAE ||ANCHOR PHASE 3|

.

TO OBTAIN LOCATION OF PARTICIPANTS UNDERGROUND FACILITIES BEFORE YOU

DIG IN HAWAII, CALL HAWAII ONE CALL

www.callbeforeyoudig.org

REQUIRES MIN OF 2

WORKING DAYS NOTICE

Call before you dig. BEFORE YOU EXCAVATE

44-256 KANEOHE BAY DRIVE KAILUA, HAWAII 96734

TMK: 4-4-012:003

SHEET TITLE:

TITLE SHEET

SHEET NO:

PROJECT CONTACTS

PROPERTY OWNER: HAWAII ELECTRIC CO. INC. P.O. BOX 2750 HONOLULU, HAWAII 96840

SYNERGY/ ADVANTAGE ENGINEERS 758 KAPAHULU AVE, STE100 #940 HONOLULU, HI 96816 CONTACT: KENNETH HUANG (808) 341-2716

SAC/ZONING/PERMITTING:

APPLICANT 3375 KOAPAKA STREET, SUITE G300 HONOLULU, HI 96819

STRUCTURAL ENGINEERING: VECTOR STRUCTURAL ENGINEERING, LLC 651 W. GALENA PARK BLVD., SUITE 101 DRAPER, UT 84020 PHONE: (801) 990-1775

ELECTRICAL ENGINEERING: SYNERGY/ ADVANTAGE ENGINEERS 758 KAPAHULU AVE, STE100 #940 HONOLULU, HI 96816 CONTACT: MATT MIURA PHONE: (808) 590-9837

WWW.VECTORSE.COM

SITE SUMMARY

SITE ADDRESS: 44-256 KANEOHE BAY DRIVE KAILUA, HAWAII 96734

TAX MAP KEY: 4-4-012:003 ZONING CLASSIFICATION: P-1 RESTRICTED PRESERVATION SETBACKS: N/A HEIGHT LIMIT: N/A FLOOD ZONE: D STATE LAND USE: CONSERVATION OCCUPANY CLASSIFICATION: U (U IMPROVEMENT)

CONSTRUCTION TYPE: TYPE II-B TOP OF EXISTING STRUCTURE: 37'-4" (TOP OF WOOD POLE) TOTAL NUMBER OF BUILDING STORIES: 3 PROJECT FLOOR LEVEL: GROUND

EXISTING TOTAL FLOOR AREA: 200 SF NEW FLOOR AREA: 0 SF TOTAL FLOOR AREA: 200 SF

EXISTING BUILDING AUTOMATIC FIRE SPRINKLER SYSTEM: NONE

SPECIAL INSPECTION REQUIRED: YES-REFER TO SHEET GOO1, GOO3

UTILITY SURVEYOR

POWER: COMPANY: HECO

COMPANY: HAWAIIAN TELECOM

PROJECT DESCRIPTION

T-MOBILE PROPOSES TO MODIFY (E) WIRELESS TELECOMMUNICATIONS SITE BY:

ANTENNA: EXISTING (3), REMOVE (0), INSTALL (3), FINAL (6).
RRU: EXISTING (3), REMOVE (0), INSTALL (3), FINAL (6).
TMA: EXISTING (9), REMOVE (9), INSTALL (0), FINAL (0).
HYBRID: EXISTING (3) 6x12, INSTALL (3) 6x12, FINAL (6) 6x12.
COAX: EXISTING (24) COAX, REMOVE (24) COAX, INSTALL (0), FINAL (0) COAX.
CABINETS: EXISTING (1), REMOVE (1), INSTALL (2), FINAL (2).
INSTALLATION OF (1) NEW ANTENNA SUPPORT PIPE MAST
RELOCATE AND REPLACE PPC
REMOVE BRIL

DIPLEXERS: EXISTING (6), REMOVE (6), INSTALL (0), FINAL (0) REPLACE CABLE SUPPORT FRAME AND RELOCATE GPS ANTENNA

LATITUDE / LONGITUDE

LAT: 21° 25′ 34.7″ N LONG: 157° 45' 32.3" W

AMENDMENTS

21.42629444 -157.75896900

CODE COMPLIANCE

LONG:

ALL CONSTRUCTION, ALTERATION, OR DEMOLITION SHALL BE PERFORMED AND MATERIALS INSTALLED IN ACCORDANCE WITH THE CURRENT EDITIONS OF THE FOLLOWING CODES AS ADOPTED BY THE LOCAL GOVERNING AUTHORITIES TO INCLUDE COMPLIANCE WITH THE LATEST FEDERAL STATE, AND LOCAL AMENDMENTS, REGULATIONS AND ORDINANCES.

- 2018 IBC INTERNATIONAL BUILDING CODE W/ HAWAII AMENDMENTS
- 2018 NFPA-1 NATIONAL FIRE PROTECTION ASSOCIATION CODE W/STATE AND LOCAL AMENDMENTS
- 2017 NEC NATIONAL ELECTRICAL CODE W/ ROH, CHAPTER 17 2018 IECC - INTERNATIONAL ENERGY CONSERVATION CODE W/ CURRENT
- HAWAII ENERGY CONSERVATION CODE W/ HAR, CH. 3-181.1, PER HRS,

CITY AND COUNTY OF HONOLULU **REVISED ORDINANCE CHAPTER 32** HONOLULU COUNTY CODE 1990 AS AMENDED

TO THE BEST OF MY KNOWLEDGE, THIS PROJECT'S DESIGN SUBSTANTIALLY CONFORMS TO THE BUILDING ENERGY CONSERVATION CODE FOR:

> BUILDING COMPONENT SYSTEMS ELECTRICAL COMPONENT SYSTEMS MECHANICAL COMPONENT SYSTEMS

> > DATE:

SIGNATURE: WELLS HOLMES NAME:

LICENSE NO.: 16863-S

TITLE: LICENSED PROFESSIONAL ENGINEER

THE FACILITY IS UNMANNED AND NOT FOR CONTINUOUS HUMAN HABITATION. HANDICAPPED ACCESS IS NOT REQUIRED PER IBC OR HI CODE. SECTION 1103.2.7 (LIMITED ACCESS SPACES)


DRAWING INDEX


VICINITY MAP


GENERAL LOCATION MAP

ACCESSIBILITY REQUIREMENTS

SECTION 1103.2.9 (EQUIPMENT SPACES)

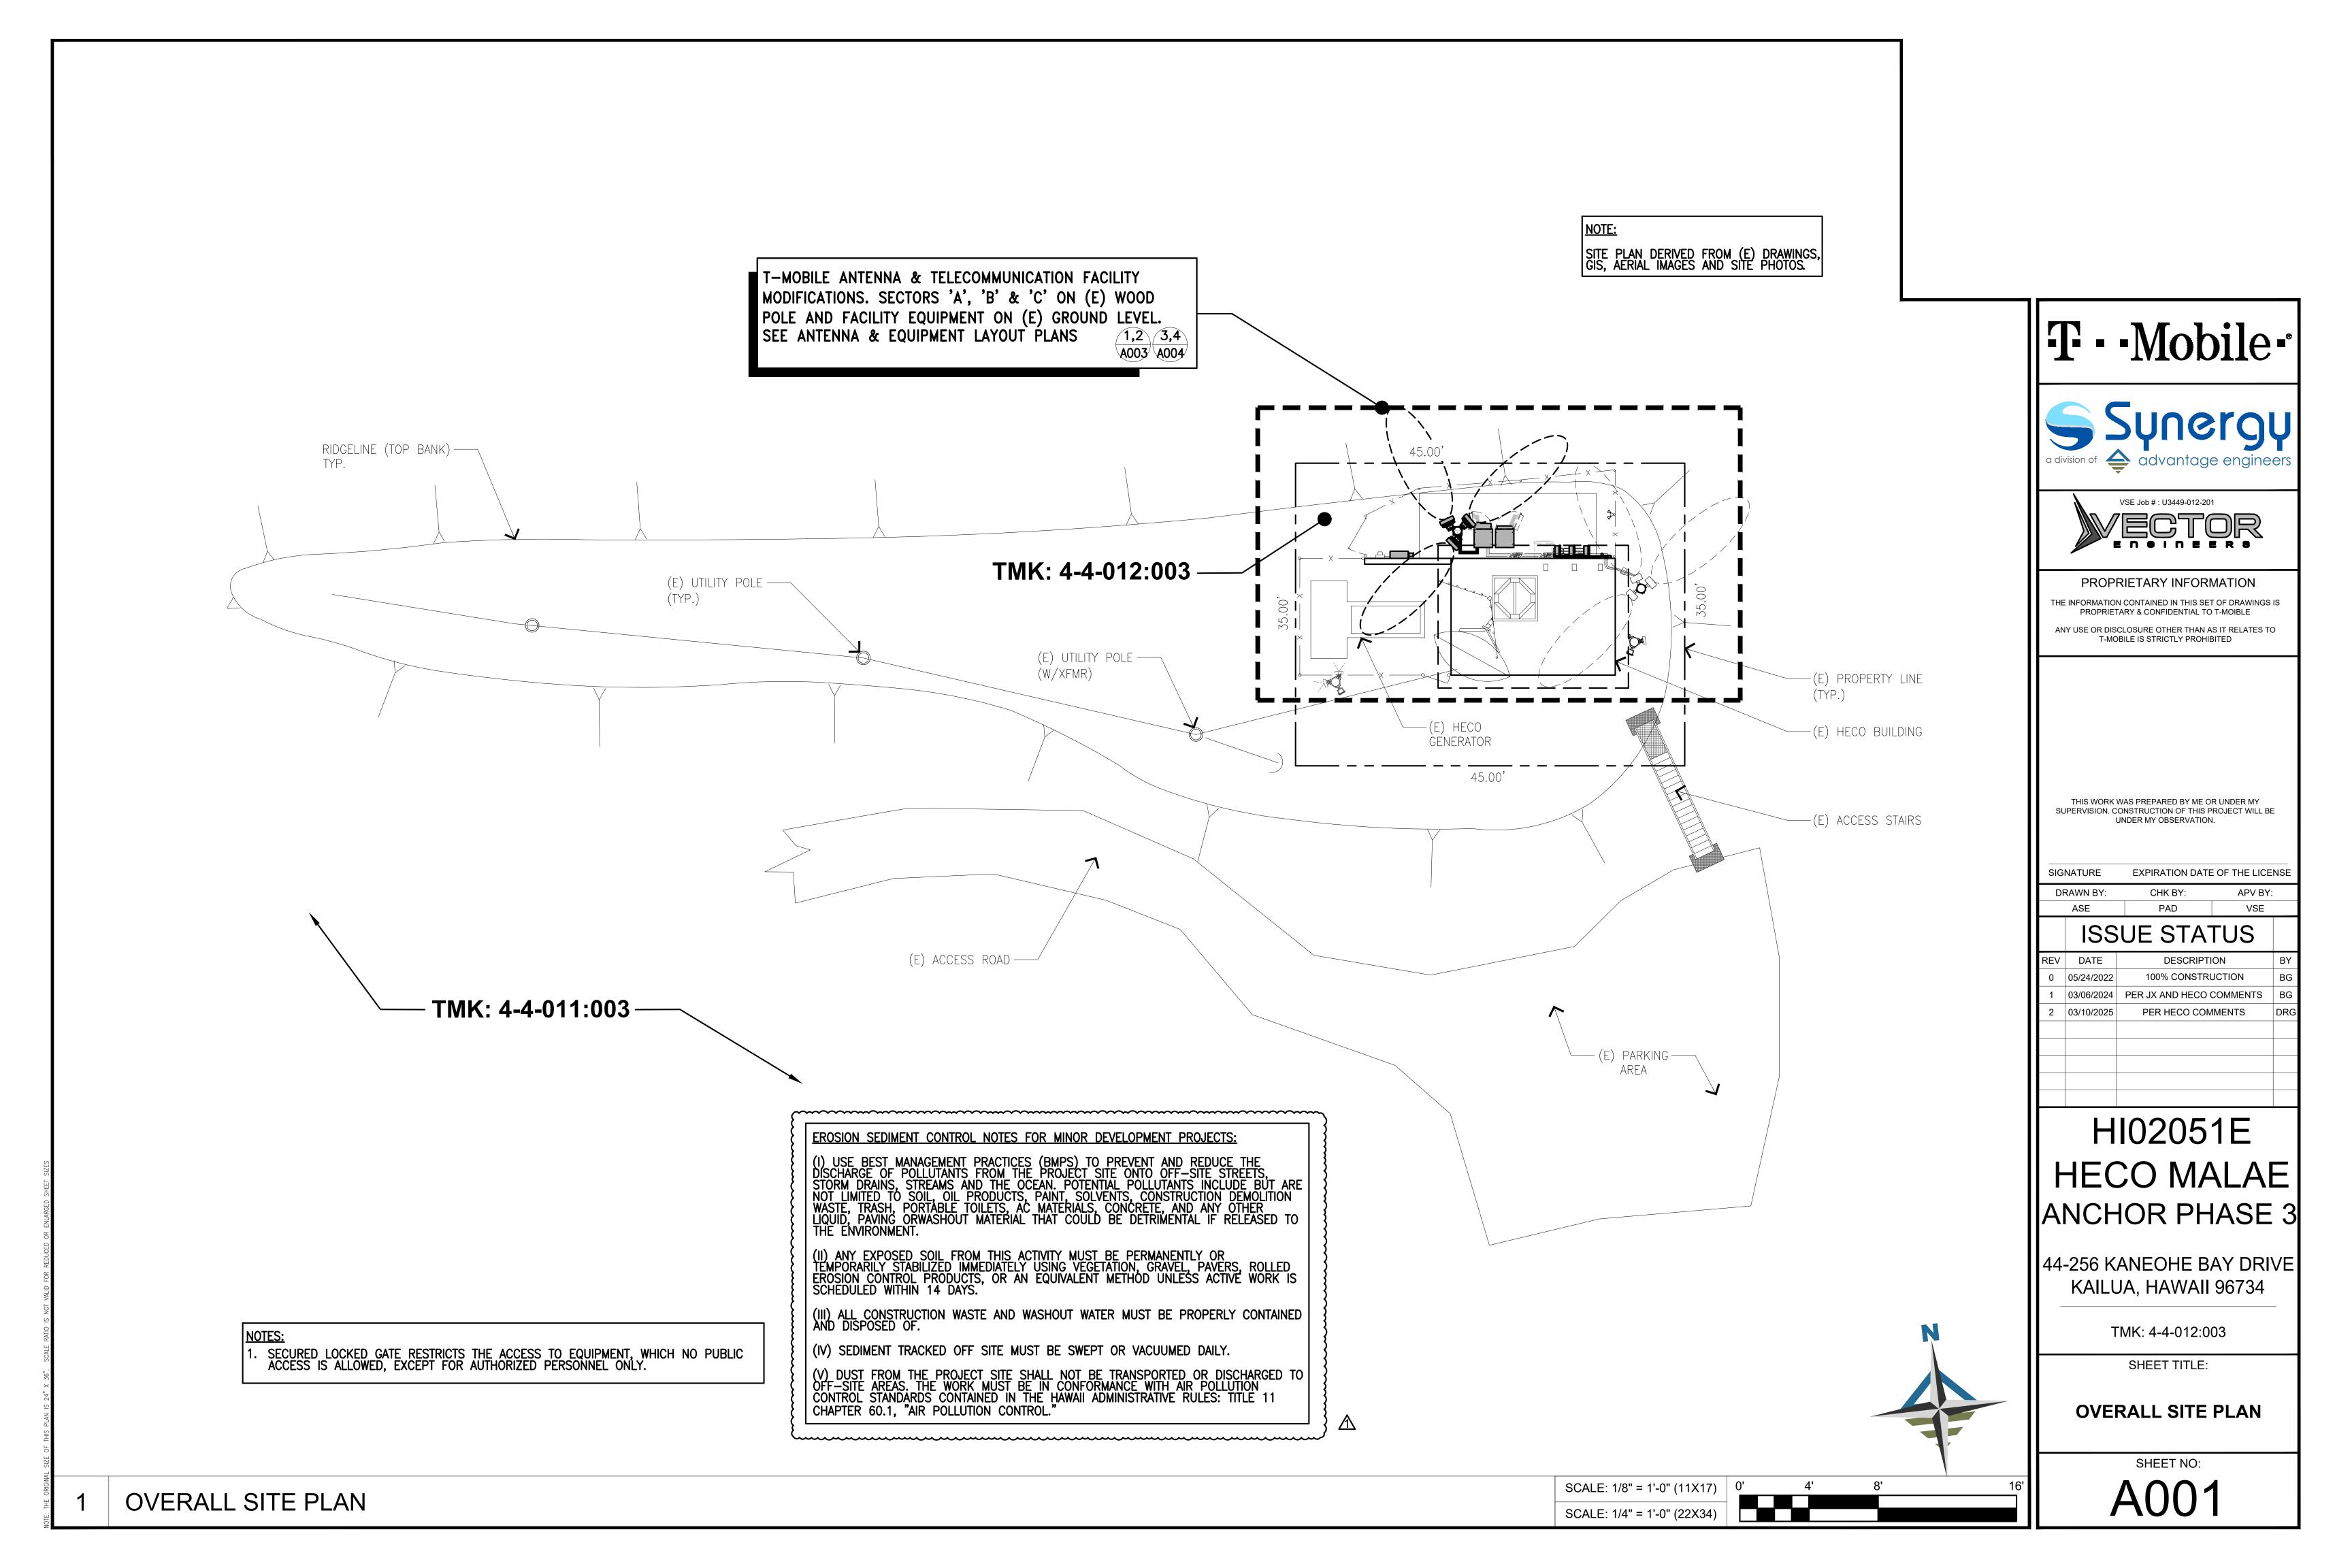

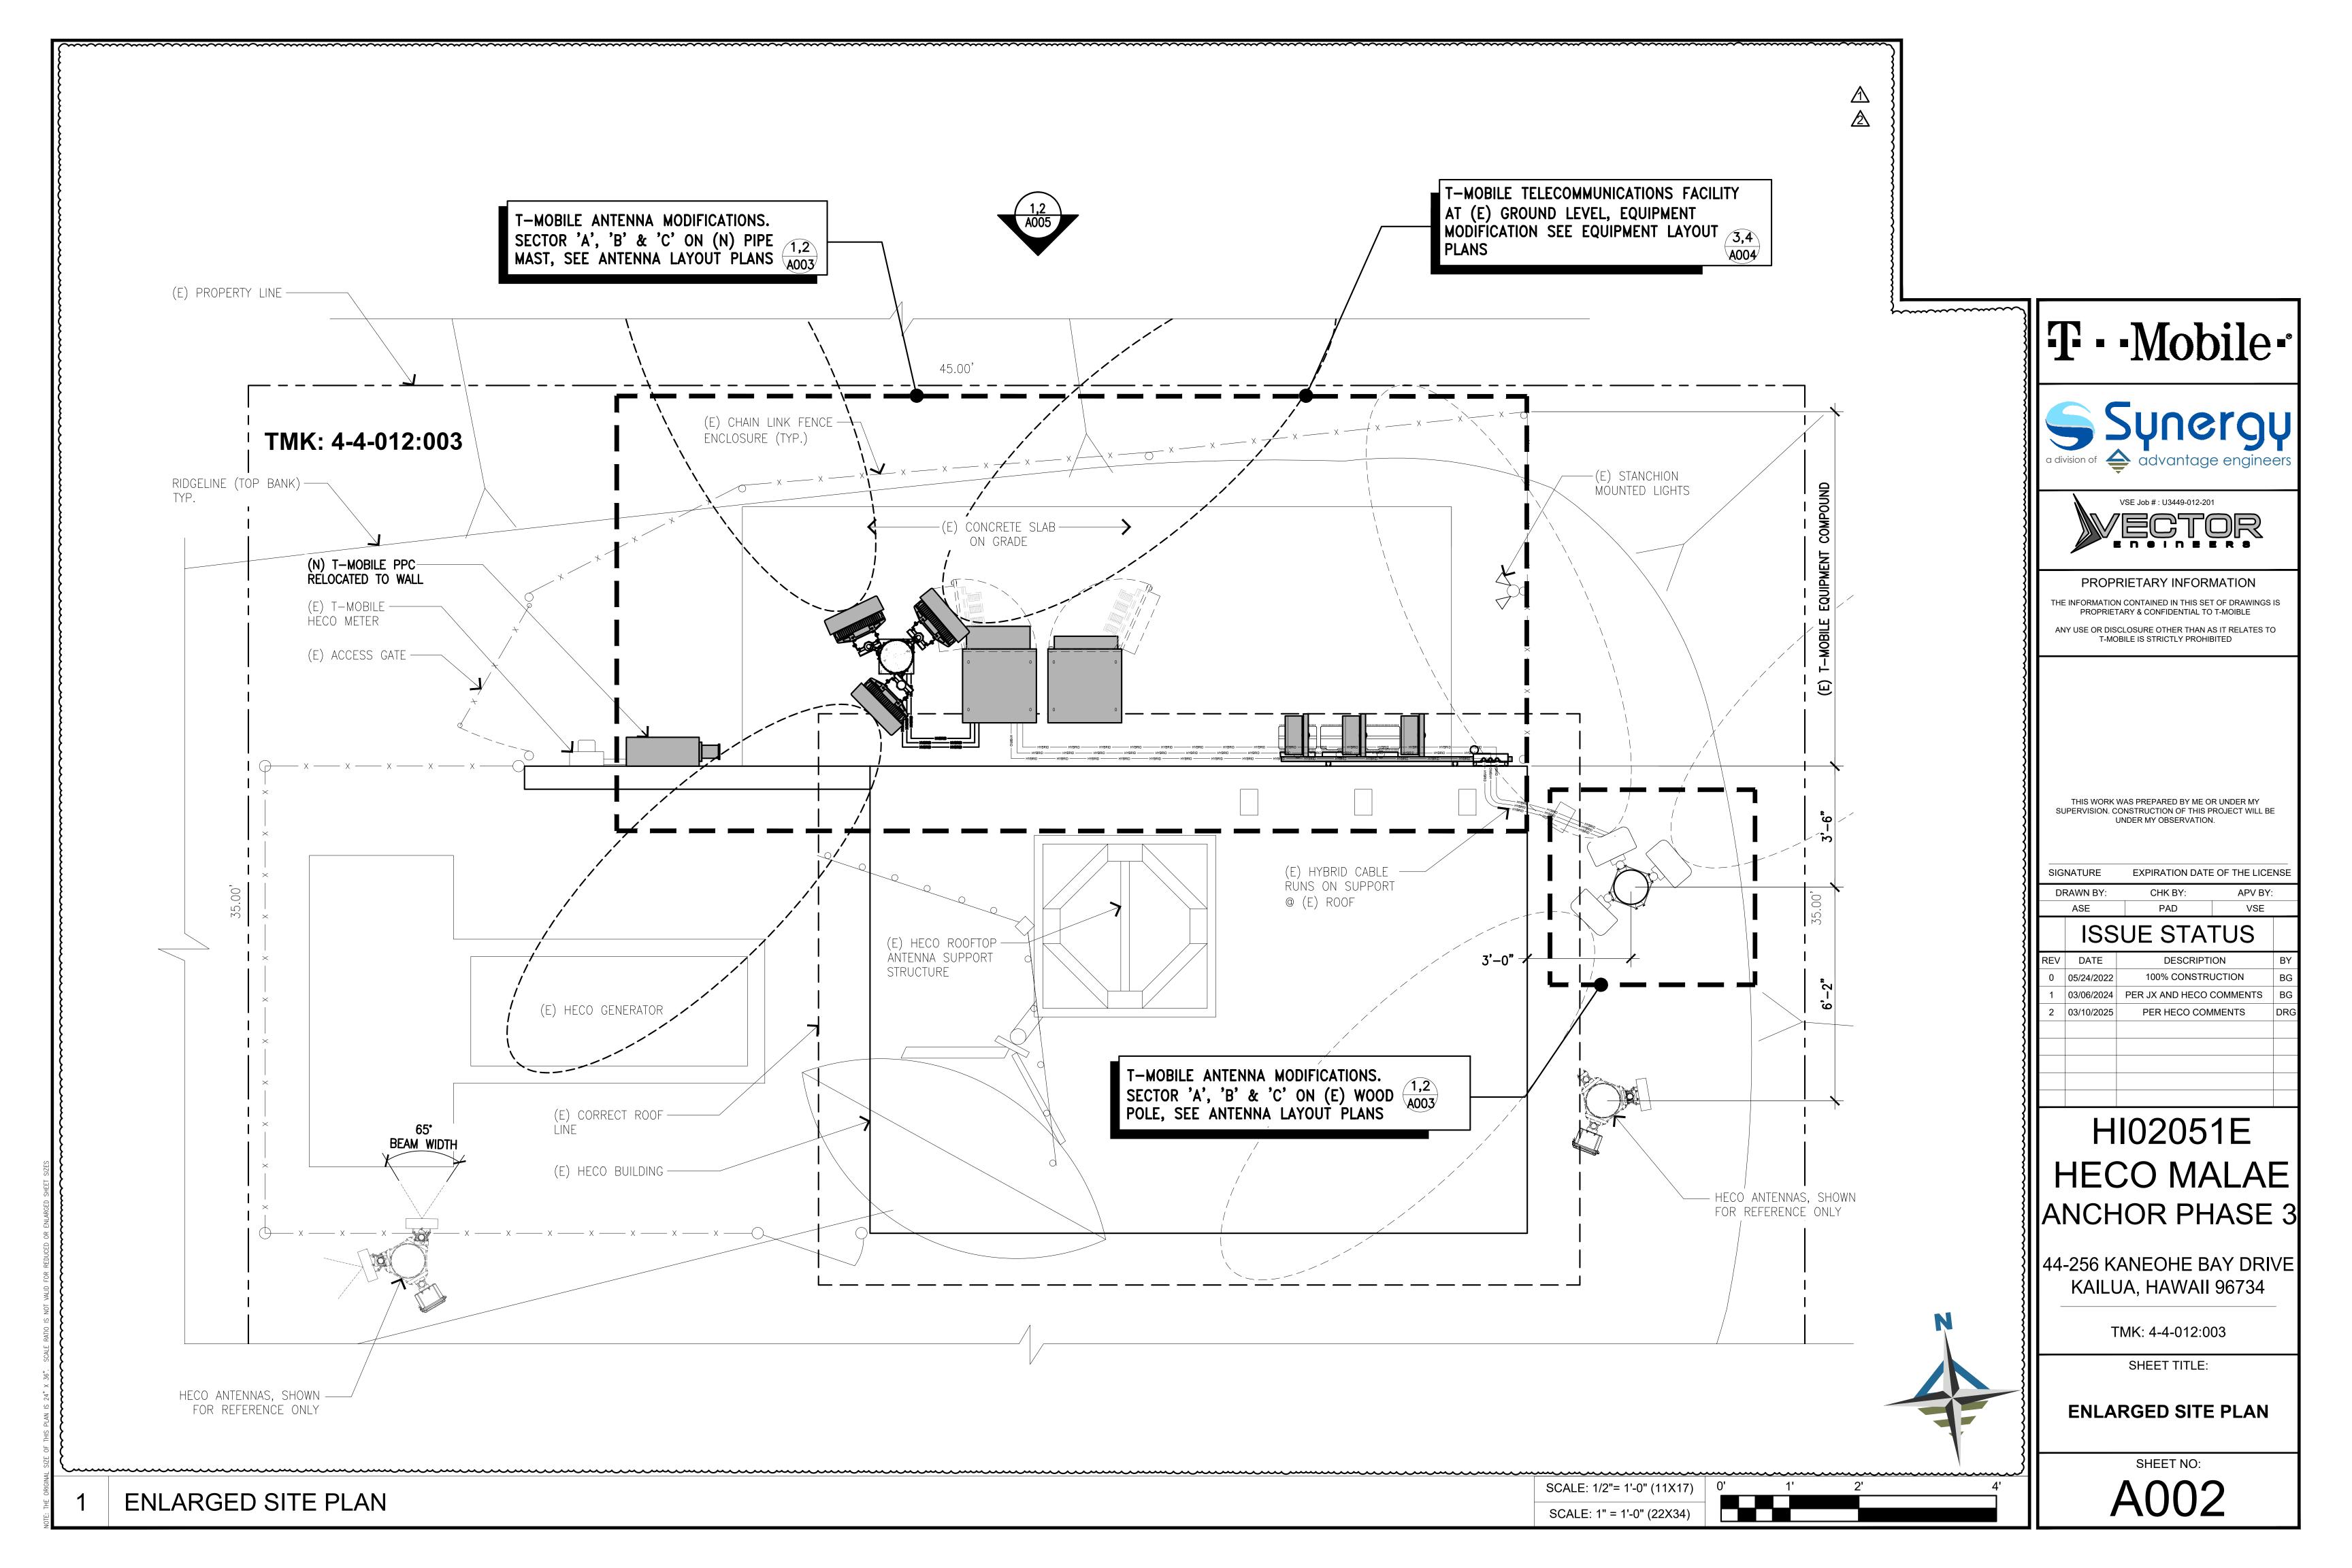

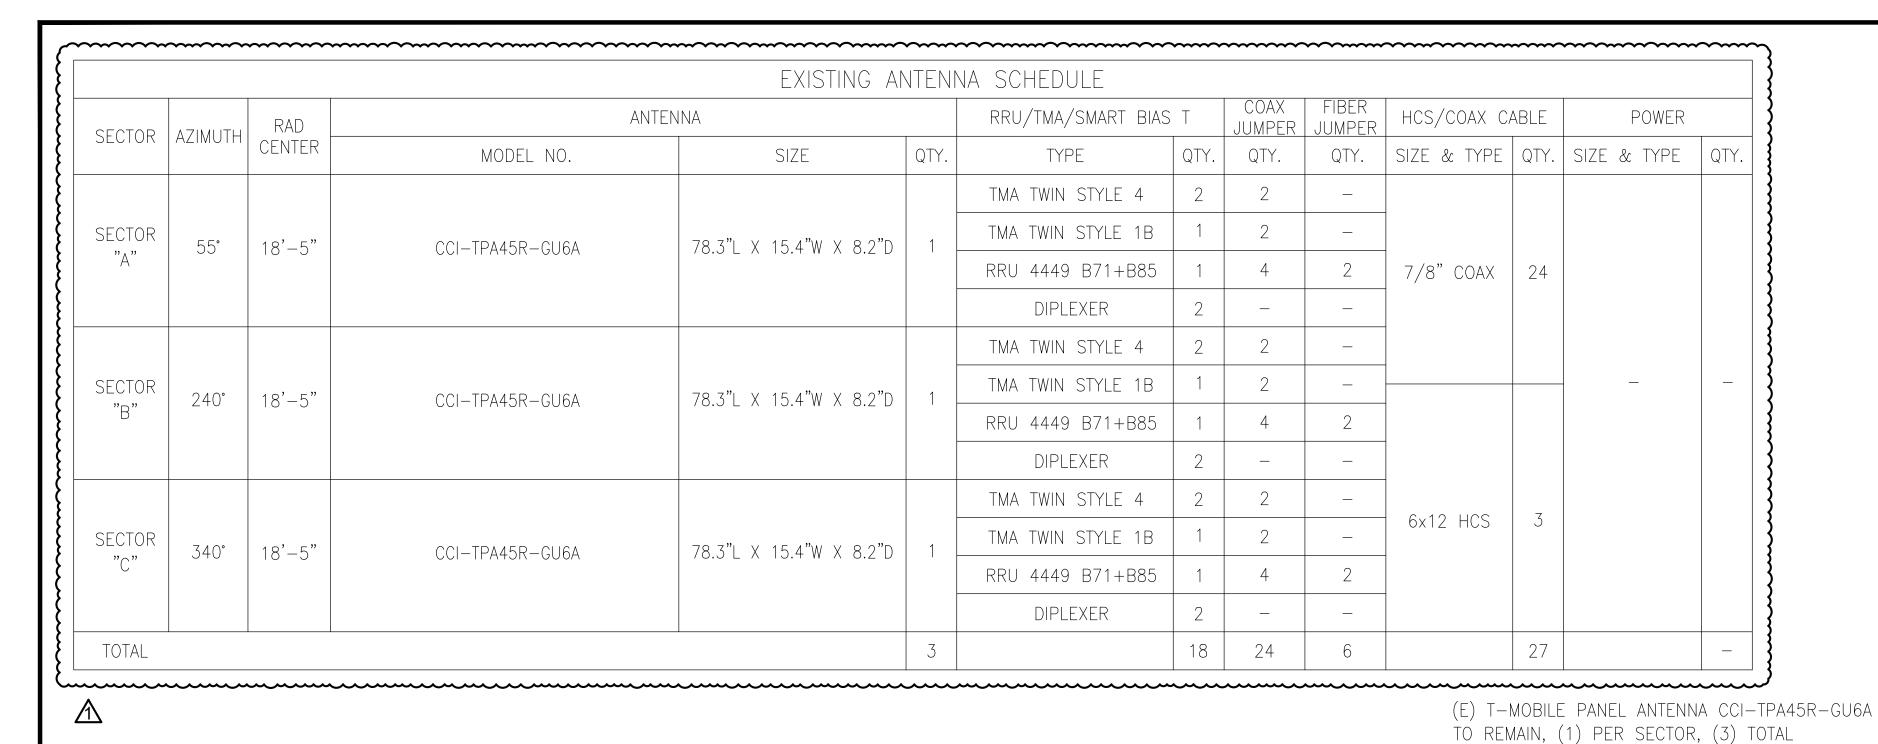

SECTOR 'C'
340'

SECTOR 'A'
55'

13'-8" EXCLUSION
DISTANCE, (TYP)

(E) T-MOBILE TMA STYLE 4
TO BE REMOVED
(2) PER SECTOR, (6) TOTAL
(E) T-MOBILE TMA STYLE 1B
TO BE REMOVED
(1) PER SECTOR, (3) TOTAL


SECTOR 'B'
240'

(E) ANTENNA AT (E) WOOD POLE

SCALE: 3/4" = 1'-0" (11X17) 0'_

SCALE: 1-1/2" = 1'-0" (22X34)

1 (E) ANTENNA LAYOUT PLAN

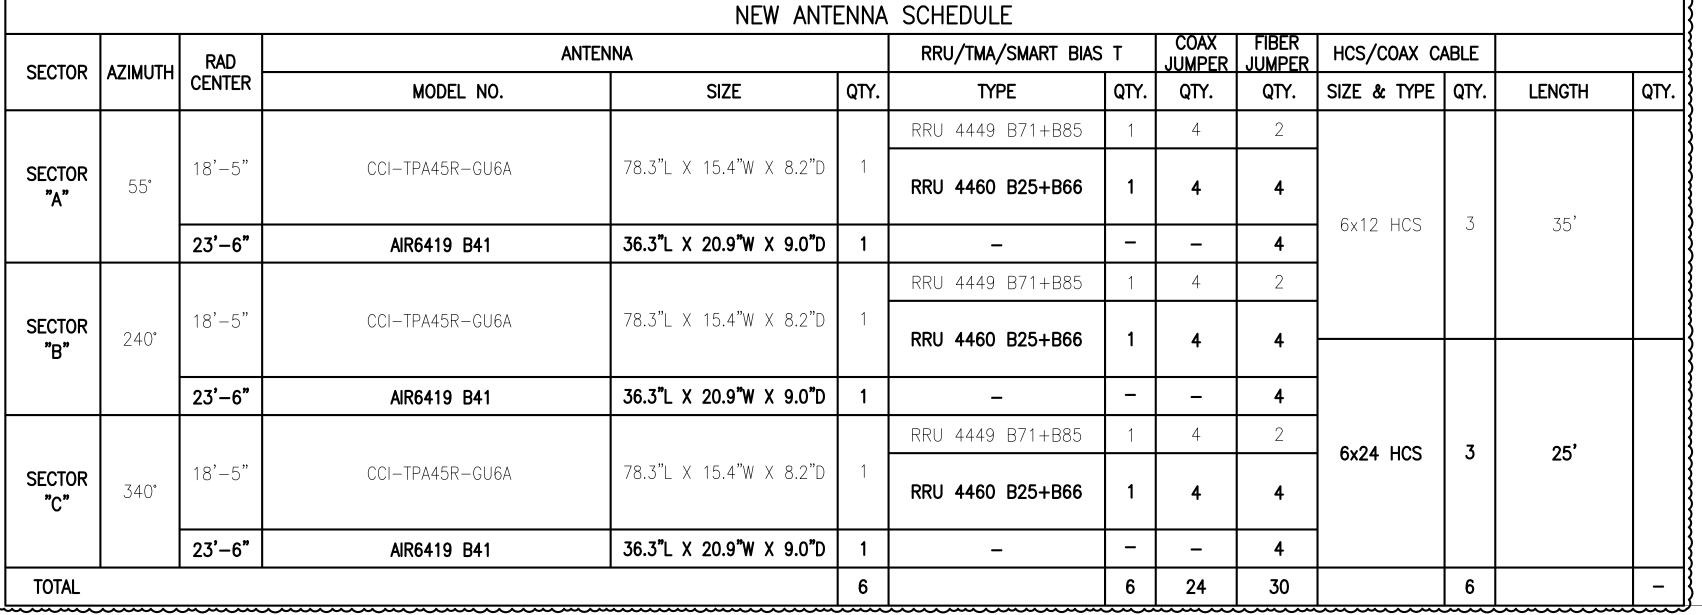

(E) ANTENNA AT (E) WOOD POLE

13'-8" EXCLUSION DISTANCE, (TYP)

SECTOR 'A'

55°

(E) ANTENNA AT (E) WOOD POLE

13'-8" EXCLUSION DISTANCE, (TYP)

SECTOR 'C'

SECTOR 'A'

55°

(E) T-MOBILE PANEL ANTENNA CCI-TPA45R-GU6A —\ SECTOR 'C'

(N) 25'-0" PIPE MAST

(N) 12" x 12" CONCRETE BASE

(N) T-MOBILE PANEL ANTENNA

(N) T-MOBILE PANEL ANTENNA

(N) 3) 6x24

(N) 3) 6x24

(N) ANTENNA AT (N) PIPE MAST

NOTES:

1. CAP AND WEATHERPROOF ALL UNUSED PORTS

(N) ANTENNA LAYOUT PLAN

SCALE: 1/2"= 1'-0" (11X17) 0' 1' 2'

SCALE: 1" = 1'-0" (22X34)

T·Mobile





PROPRIETARY INFORMATION

THE INFORMATION CONTAINED IN THIS SET OF DRAWINGS IS
PROPRIETARY & CONFIDENTIAL TO T-MOIBLE

ANY USE OR DISCLOSURE OTHER THAN AS IT RELATES TO
T-MOBILE IS STRICTLY PROHIBITED

THIS WORK WAS PREPARED BY ME OR UNDER MY SUPERVISION. CONSTRUCTION OF THIS PROJECT WILL B UNDER MY OBSERVATION.

SIGNATURE EXPIRATION DATE OF THE LICENSE

DRAWN BY: CHK BY: APV BY:

ISSUE STATUS

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HI02051E HECO MALAE ANCHOR PHASE 3

44-256 KANEOHE BAY DRIVE KAILUA, HAWAII 96734

TMK: 4-4-012:003

SHEET TITLE:

ANTENNA LAYOUT
PLANS
& ANTENNA SCHEDULE

SHEET NO:

A003

